RESOLUTION NO.	

A RESOLUTION OF THE CITY COUNCIL OF THE CITY OF MESQUITE, TEXAS, APPROVING THE TERMS AND CONDITIONS OF THE SEVENTH AMENDMENT TO THE COMMUNICATIONS FACILITIES LICENSE WITH CELLCO PARTNERSHIP D/B/A VERIZON WIRELESS ("LICENSE AGREEMENT"), TO AMEND THE SITE PLAN TO REFLECT UPDATED EQUIPMENT LOCATED ON THE CITY'S SERVICE CENTER COMMUNICATIONS TOWER, AS SPECIFIED IN THE LICENSE AGREEMENT: AUTHORIZING THE CITY MANAGER TO EXECUTE AND ADMINISTER THE LICENSE AGREEMENT ON BEHALF OF THE CITY.

WHEREAS, the City of Mesquite (the "City") and Dallas MTA, L.P., d/b/a Verizon Wireless entered into a Communications Facilities License on October 13, 1997 (the "Agreement"); and

WHEREAS, the Agreement was previously amended on June 5, 2012, March 19, 2015, July 30, 2015, July 18, 2017, March 7, 2018, and December 3, 2018, and

WHEREAS, Dallas MTA, L.P., d/b/a Verizon Wireless was dissolved by operation of law effective December 31, 2018, and its assets and liabilities, including the Agreement, were redistributed to Cellco Partnership d/b/a Verizon Wireless ("Licensee"); and

WHEREAS, Licensee is requesting a seventh amendment to the Agreement that will allow Licensee to amend the site plan to reflect updated equipment located on the City's Service Center Communications Tower.

NOW, THEREFORE, BE IT RESOLVED BY THE CITY COUNCIL OF THE CITY OF MESQUITE, TEXAS:

SECTION 1. That the terms and conditions of the Seventh Amendment to Communications Facilities License (the "Amendment"), attached hereto as Exhibit A, are found to be acceptable and in the best interest of the City and its citizens, and are hereby approved.

SECTION 2. That the City Manager is hereby authorized to finalize and execute the Amendment and all other documents necessary to consummate the transactions contemplated by the Amendment.

SECTION 3. That the City Manager is further hereby authorized to administer the Agreement, as amended, on behalf of the City including, without limitation, the City Manager shall have the authority to: (i) provide any notices required or permitted by the Agreement; (ii) approve minor amendments to the Agreement provided such amendments do not change either party's use of the property or change the rent charged; (iii) exercise any rights and remedies available to the City under the Agreement; and (iv) execute any notices, amendments, approvals, consents, denials, and waivers authorized by the Agreement.

Administration / Seventh Amendment to Communications	Facilities License with	Verizon
December 6, 2021		
Page 2 of 2		

DULY RESOLVED by the City Council of the City of Mesquite, Texas, on the 6th day of December 2021.

	Daniel Alemán, Jr. Mayor
ATTEST:	APPROVED AS TO LEGAL FORM:
Sonja Land	David L. Paschall
City Secretary	City Attorney

EXHIBIT A

SEVENTH AMENDMENT TO THE COMMUNICATIONS FACILITIES LICENSE AGREEMENT BETWEEN

THE CITY OF MESQUITE, TEXAS, AND
CELLCO PARTNERSHIP d/b/a VERIZON WIRELESS

Licensee Site Name: Samuel Park Licensee Contract No.: 25519

SEVENTH AMENDMENT TO COMMUNICATIONS FACILITIES LICENSE

This SEVENTH AMENDMENT TO COMMUNICATIONS FACILITIES LICENSE ("Seventh Amendment"), dated as of the Effective Date (as hereinafter defined), is by and between the City of Mesquite, a Texas home rule municipality, having a mailing address of 1515 N. Galloway Avenue, Mesquite, TX 75149 ("City") and Cellco Partnership d/b/a Verizon Wireless, having a principal office located at One Verizon Wireless Way, Mail Stop 4AW100, Basking Ridge, New Jersey 07920 ("Licensee").

WHEREAS, City and Dallas MTA, L.P. d/b/a Verizon Wireless entered into a Communications Facilities License dated October 13, 1997, whereby City licensed to Licensee use of certain premises therein described that are a portion of the premises owned by the City located at 1101 E. Main Street, Mesquite, Texas 75149 (the "Original License Agreement"); and

WHEREAS, the Original License Agreement has been amended by: (i) the First Amendment to Communications Facilities License dated as of June 5, 2012 ("First Amendment"); (ii) the Second Amendment to Communications Facilities License dated as of March 19, 2015 ("Second Amendment"); (iii) the Third Amendment to Communications Facilities License dated as of July 30, 2015 ("Third Amendment"); (iv) the Fourth Amendment to Communications Facilities License dated as of July 18, 2017 ("Fourth Amendment"); (v) the Fifth Amendment to Communications Facilities License dated March 7, 2018 ("Fifth Amendment"); and (vi) the Sixth Amendment to Communications Facilities License dated March 5, 2019 ("Sixth Amendment"); and

WHEREAS, the Original License Agreement, as amended by the First Amendment, the Second Amendment, the Third Amendment, the Fourth Amendment, the Fifth Amendment, and the Sixth Amendment are collectively referred to in this Seventh Amendment as the "Agreement"; and

WHEREAS, all capitalized terms used in this Seventh Amendment but not defined herein have the same meanings as defined in the Agreement; and

WHEREAS, pursuant to Assistant Secretary's Certificate dated January 14, 2019, Dallas MTA, L.P. was dissolved by operation of law effective December 31, 2018 and its assets and liabilities redistributed to Cellco Partnership; and

WHEREAS, the City and Licensee desire to further amend the Agreement as more fully set forth herein.

NOW THEREFORE, in consideration of the foregoing and other good and valuable consideration, the receipt and sufficiency of which are hereby acknowledged, City and Licensee agree as follows:

- 1. **Amendment of Site Plan.** The SITE PLAN attached as Attachment A-2(B) to the Sixth Amendment is hereby deleted and replaced with **Attachment A-2(C)**, attached hereto and incorporated herein by reference. As of the Effective Date, all references in the Agreement to Attachment A-2, Attachment A-2(A), and Attachment A-2(B) are references to Attachment A-2(C).
- 2. **Amendment of Equipment Compound and Antenna Facilities.** The list of Equipment and Compound Facilities attached as Attachment B-5 to the Sixth Amendment is hereby deleted and replaced with **Attachment B-6**, attached hereto and incorporated herein by reference. As of the Effective Date, all references in the Agreement to Attachments B, B-1, B-2, B-3, B-4, and B-5 are references to Attachment B-6.
- 3. **Equipment**. From and after the Effective Date, the City agrees that Licensee may install the equipment described in Attachment B-6 on the Premises.
- 4. **Permitted Antenna Facilities and Equipment.** From and after the Effective Date, the Antenna Facilities and equipment permitted under the terms of the Agreement are limited to the Antenna Facilities and equipment described in Attachment B-6.
- 5. Other Terms and Conditions Remain. In the event of any inconsistencies between the Agreement and this Seventh Amendment, the terms of this Seventh Amendment shall control. This Seventh Amendment amends the Agreement in no other manner except as expressly set forth herein. The Parties acknowledge and agree that Exhibit A-3 of the Agreement has not been revised in any way by this Amendment. Except as expressly set forth in this Seventh Amendment, the Agreement is unmodified and remains in full force and effect. Each reference to the "Agreement" in the Agreement shall be deemed to refer to the Original License Agreement, as amended by the First Amendment, the Second Amendment, the Third Amendment, the Fourth Amendment, the Fifth Amendment, the Sixth Amendment, and this Seventh Amendment.
- 6. **Effective Date.** This Seventh Amendment shall not be effective unless and until it is executed by both the City and the Licensee. "**Effective Date**" as used herein means the later of the two dates this Seventh Amendment is executed by the City and Licensee.
- 7. **Signing Authority.** City and Licensee each warrant to the other that the person executing this Seventh Amendment on behalf of the warranting party has the full right, power

and authority to enter into, and execute, this Seventh Amendment on that party's behalf, and that no consent from any other person or entity is necessary as a condition precedent to the legal effect of this Seventh Amendment.

8. **Entire Agreement.** This Seventh Amendment, together with its attachments, sets forth the entire agreement of the parties with respect to the matters set forth herein. There are no oral agreements between the parties.

[Signatures on following page]

IN WITNESS WHEREOF, the City and the Licensee have executed this Seventh Amendment on the dates set forth below:

CITY	/:
•	of Mesquite, as home rule municipality
By:	
Printe Title:	ed Name:
Date:	
	ROVED AS TO FORM:
By: _	
Printe	ed Name:
Time.	
Date:	
LICE	ENSEE:
Cellc	o Partnership d/b/a Verizon Wireless
By:	Docusigned by: Amanda Eastin F053F9A95E85492
By: _	Amanda Eastin
Ву: _	Amanda Eastin F053F9A95E85492
Ву: _	Amanda Eastin Verizon Sr. Manager – Central Texas Modifications, Small Cells, MLA &
Ву: _	Amanda Eastin Verizon Sr. Manager – Central Texas

ATTACHMENT A-2(C)


Site Plan

(See attached)



5G L-SUB 6 PROJECT

SITE NAME: SAMUEL_PARK LOCATION CODE: 104821 STRUCTURE TYPE: 250'-0" SELF-SUPPORT TOWER

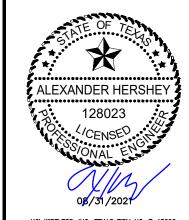

KGI WIRELESS, INC. TEXAS FIRM NO. F-15692 FIRM REGISTRATION RENEWAL 12/31/2021 PE LICENSE RENEWAL 06/30/2022

REVISION

PROJECT SUMMARY

LATITUDE: 32° 46' 07.42" N

LONGITUDE:

96° 35' 10.95" W GROUND ELEVATION: ± 508.5' AMSL

SITE ADDRESS:

1101 E MAIN ST MESQUITE, TX 75149 DALLAS COUNTY

CONSTRUCTION TYPE: UNMANNED TELECOMMUNICATIONS

CITY OF MESQUITE JURISDICTION:

SCOPE OF WORK

- THIS WIRELESS COMMUNICATIONS FACILITY IS NOT INTENDED FOR HUMAN OCCUPANCY
- THIS FACILITY DOES NOT REQUIRE POTABLE WATER AND WILL NOT PRODUCE ANY SEWAGE.
- THE SCOPE OF WORK CONSISTS OF MODIFYING THE EXISTING WIRELESS INSTALLATION: A. REMOVE (6) RRHS (REMOTE RADIO HEADS)
 - REMOVE (10) COAX CABLES REMOVE (2) HYBRID CABLES INSTALL (3) ANTENNAS
 - INSTALL (6) RRHS INSTALL (4) HYBRID DISTRIBUTION BOXES
 - (2) HYBRID CABLES INSTALL

APPLICABLE CODES & STANDARDS

- INTERNATIONAL BUILDING CODE, 2015 EDITION AS ADOPTED BY LOCAL JURISDICTION NATIONAL ELECTRICAL CODE, 2014 EDITION
- AS ADOPTED BY LOCAL JURISDICTION



Know what's below. Call before you dig.

APPLICANT:

VERIZON WIRELESS 5804 TRI COUNTY PARKWAY SCHERTZ, TX 78154 CONTACT: DANNY DELEON PHONE: 806.281.3853

CONTACTS

SITE ACQUISITION:

KGI WIRELESS, INC. BUILDING THREE, SUITE 370 805 LAS CIMAS PKWY. AUSTIN, TX 78746 PHONE: 512.345.9595

ENGINEER:

KGI WIRELESS, INC. BUILDING THREE, SUITE 370 805 LAS CIMAS PKWY. AUSTIN, TX 78746 TYLER BOLINGER, P.E. PRINCIPAL ENGINEER PHONE: 512.334.3256

UTILITY PROVIDER

AT SITE



VICINITY MAP

TEAM SIGN-OFF

SITE ACQUISITION DATE CONSTRUCTION SUPERVISOR DATE RF ENGINEERING DATE FQUIPMENT DATE TELCO DATE

CONSTRUCTION MANAGER

THE ABOVE PARTIES HEREBY APPROVE AND ACCEPT THESE DOCUMENTS AND AUTHORIZE CONTRACTOR TO PROCEED WITH THE CONSTRUCTION DESCRIBED HEREIN. ALL DOCUMENTS ARE SUBJECT TO REVIEW BY THE LOCAL BUILDING DEPARTMENT AND MAY IMPOSE CHANGES OR MODIFICATIONS.

DRAWINGS INDEX

1	T1	TITLE SHEET	1	
	GN1	GENERAL NOTES	0	
	CIVIL PLA	NS		
	C1	SITE PLAN	1	
	C2	TOWER ELEVATION AND ANTENNA PLANS	1	
	С3	EQUIPMENT MOUNTING DETAILS	1	
	RF INFORMATION			
	RF1	ANTENNA SPECIFICATIONS	0	
- manually	RF2	PROPOSED EQUIPMENT SPECS	0	
	RF3	PROPOSED EQUIPMENT SPECS	0	
	RF4	PROPOSED EQUIPMENT SPECS	0	
	ATTACHME	INTS:		

MOUNT MODIFICATION DESIGN BY T.E.S., DATED 08/26/2021

DATE

THESE DRAWINGS ARE FOR PERMITTING AND CONSTRUCTION **PURPOSES**

NOTE: DRAWING SCALES ARE FOR 11"X17" SHEETS UNLESS OTHERWISE



ENGINEERING

805 LAS CIMAS PKWY BUILDING THREE, SUITE 370 AUSTIN, TX 78746 512.345.9595

> SITE NAME SAMUEL PARK

LOCATION CODE 104821

SITE ADDRESS: 1101 E MAIN ST MESQUITE, TX 75149

THESE DRAWINGS ARE THE PROPERTY OF VERIZON WIRELESS. THEY ARE INTENDED FOR THE EXCLUSIVE USE OF THIS PROJECT ONLY ANY RE-USE OF THESE PLANS (DRAWINGS) WITHOUT THE EXPRESS WRITTEN CONSENT OF VERIZON WIRELESS IS PROHIBITED.

ISSUED FOR: PERMITTING REV 0 04/01/2021 PERMITTING REV 1 08/31/2021

REVISION NO DESCRIPTION BY DATE 1 UPDATE OVP'S AND CABLES RA 08/31/2021

TITLE SHEET

SHEET NUMBER:

GENERAL NOTES

- THE CONTRACTOR SHALL SUPERVISE AND DIRECT ALL WORK USING HIS BEST SKILL AND ATTENTION.
 HE SHALL BE SOLELY RESPONSIBLE FOR ALL CONSTRUCTION MEANS, METHODS, TECHNIQUES,
 PROCEDURES AND SEQUENCES FOR COORDINATING ALL PORTIONS OF THE WORK UNDER CONTRACT.
- THE CONTRACTOR SHALL VISIT THE JOB SITE TO REVIEW THE SCOPE OF WORK AND EXISTING JOB SITE CONDITIONS INCLUDING, BUT NOT LIMITED TO, MECHANICAL, ELECTRICAL SERVICE, AND OVERALL CONDITION.
- THE CONTRACTOR SHALL VERIFY ALL EXISTING CONDITIONS AND DIMENSIONS PRIOR TO SUBMITTING
 HIS BID. ANY DISCREPANCIES, CONFLICTS OR OMISSIONS, ETC. SHALL BE REPORTED TO VERIZON
 BEFORE PROCEEDING WITH THE WORK.
- 4. THE CONTRACTOR SHALL PROTECT ALL AREAS FROM DAMAGE WHICH MAY OCCUR DURING CONSTRUCTION. ANY DAMAGE TO NEW AND EXISTING CONSTRUCTION, STRUCTURE, OR EQUIPMENT SHALL BE IMMEDIATELY REPAIRED OR REPLACED TO THE SATISFACTION OF THE TENANT OR BUILDING OWNER, OR OWNER'S REPRESENTATIVE AT THE EXPENSE OF THE CONTRACTOR.
- 5. THE CONTRACTOR SHALL BE RESPONSIBLE FOR, AND SHALL REPLACE OR REMEDY ANY FAULTY, IMPROPER, OR INFERIOR MATERIALS OR WORKMANSHIP OR ANY DAMAGE WHICH SHALL APPEAR WITHIN ONE YEAR AFTER THE COMPLETION AND ACCEPTANCE OF THE WORK UNDER THIS CONTRACT.
- 6. THE CONTRACTOR SHALL REMOVE ALL RUBBISH AND WASTE MATERIALS ON A REGULAR BASIS, AND SHALL EXERCISE STRICT CONTROL OVER JOB CLEANING THROUGHOUT CONSTRUCTION, INCLUDING FINAL CLEAN-UP UPON COMPLETION OF WORK. ALL AREAS ARE TO BE LEFT IN A BROOM CLEAN CONDITION AT THE END OF EACH DAY.
- 7. THE CONTRACTOR SHALL SAFEGUARD THE OWNER'S PROPERTY DURING CONSTRUCTION AND SHALL REPLACE ANY DAMAGED PROPERTY OF THE OWNER TO ORIGINAL CONDITION OR BETTER.
- 8. IT SHALL BE THE RESPONSIBILITY OF THE CONTRACTOR TO LOCATE ALL EXISTING UTILITIES, WHETHER SHOWN HEREIN OR NOT, AND TO PROTECT THEM FROM DAMAGE. THE CONTRACTOR SHALL BEAR ALL EXPENSES FOR REPAIR OR REPLACEMENT OF UTILITIES OR OTHER PROPERTY DAMAGED IN CONJUNCTION WITH THE EXECUTION OF WORK.
- THE CONTRACTOR SHALL BE RESPONSIBLE FOR THE COMPLETE SECURITY OF THE SITE WHILE THE JOB IS IN PROGRESS AND UNTIL THE JOB IS COMPLETED PER CHAPTER 44 OF THE U.B.C.
- 10. THE CONTRACTOR DURING CONSTRUCTION SHALL PROVIDE TEMPORARY WATER, POWER, AND TOILET FACILITIES AS REQUIRED BY THE CITY OR GOVERNING AGENCY.
- ALL CONSTRUCTION WORK SHALL CONFORM TO THE U.B.C. AND ALL OTHER GOVERNING CODES, ALONG WITH THE GOVERNING RESTRICTIVE CODES.
- 12. THE CONTRACTOR AND ALL SUBCONTRACTORS SHALL COMPLY WITH ALL LOCAL CODE REGULATIONS AND STATE DEPARTMENT OF INDUSTRIAL REGULATIONS AND DIVISION OF INDUSTRIAL SAFETY (OSHA) REQUIREMENTS.
- 13. THE CONTRACTOR SHALL OBTAIN AND PAY FOR PERMITS, LICENSES, AND INSPECTIONS NECESSARY FOR PERFORMANCE OF THE WORK AND INCLUDE THOSE IN THE COST OF THE WORK TO THE OWNER.
- 14. FIGURED DIMENSIONS HAVE PRECEDENCE OVER DRAWINGS SCALE AND DETAIL DRAWINGS HAVE PRECEDENCE OVER SMALL SCALE DRAWINGS. CHECK ACCURACY OF ALL DIMENSIONS IN THE FIELD. UNLESS SPECIFICALLY NOTED, DO NOT FABRICATE ANY MATERIALS OFF—SITE, OR DO ANY CONSTRUCTION UNTIL THE ACCURACY OF DRAWINGS DIMENSIONS HAS BEEN VERIFIED AGAINST ACTUAL FIELD DIMENSIONS.
- 15. CONTRACTOR SHALL NOTIFY THE ENGINEER OF ANY CONFLICTS OR DISCREPANCIES WITHIN THE CONTRACT DOCUMENTS WITH THE CONTRACT DOCUMENTS AND THE FIELD CONDITIONS PRIOR TO EXECUTING THE WORK IN QUESTION.
- 16. CONTRACTOR SHALL NOTIFY THE ENGINEER IF DETAILS ARE CONSIDERED UNSOUND, UNSAFE, NOT WATERPROOF, OR NOT WITHIN THE CUSTOMARY TRADE PRACTICE. IF WORK IS PERFORMED, IT WILL BE ASSUMED THAT THERE IS NO OBJECTION TO THE DETAIL. DETAILS ARE INTENDED TO SHOW THE END RESULT OF THE DESIGN. MINOR MODIFICATIONS MAY BE REQUIRED TO SUIT JOB CONDITIONS, AND SHALL BE INCLUDED AS PART OF THE WORK.
- 17. EXISTING ELEVATIONS AND LOCATIONS TO BE JOINED SHALL BE VERIFIED BY THE CONTRACTOR BEFORE CONSTRUCTION. IF THEY DIFFER FROM THOSE SHOWN ON THE PLANS, THE CONTRACTOR SHALL NOTIFY THE ENGINEER SO THAT MODIFICATIONS CAN BE MADE BEFORE PROCEEDING WITH THE WORK.
- 18. ALL SYMBOLS AND ABBREVIATIONS USED IN THE DRAWINGS ARE CONSIDERED CONSTRUCTION STANDARDS. IF THE CONTRACTOR HAS QUESTIONS REGARDING THEIR EXACT MEANING, THE FNGINEER SHALL BE NOTIFIED FOR CLARIFICATION BEFORE PROCEEDING WITH THE WORK.
- CONTRACTOR SHALL PROVIDE ALL NECESSARY BLOCKING, BACKING, FRAMING, HANGERS OR OTHER SUPPORT FOR ALL OTHER ITEMS REQUIRING THE SAME.
- 20. CITY APPROVED PLANS SHALL BE KEPT IN A PLAN BOX AND SHALL NOT BE USED BY WORKMEN. ALL CONSTRUCTION SETS SHALL REFLECT THE SAME INFORMATION. THE CONTRACTOR SHALL ALSO MAINTAIN, IN GOOD CONDITION, ONE COMPLETE SET OF PLANS WITH ALL REVISIONS, ADDENDA AND OTHER CHANGE ORDERS ON THE PREMISE AT ALL TIMES. THESE ARE TO BE UNDER THE CARE OF THE JOB SUPERINTENDENT.
- ALL CONDUITS AND CABLE RUNS ARE DRAWN DIAGRAMMATICALLY. CONTRACTOR SHALL RUN
 CONDUITS AND CABLES IN COMPLIANCE WITH THE NATIONAL ELECTRIC CODE ALONG THE BEST
 POSSIBLE ROUTE. THE INSTALLATION OF CONDUITS AND CABLES WILL FOLLOW THE DRAWINGS AS TO
 SUPPORT AND EQUIPMENT.

22. KG'S SCOPE OF WORK DOES NOT INCLUDE A STRUCTURAL EVALUATION OF THE SITE. THUS, APPURTENANCE, EQUIPMENT, AND TRANSMISSION CABLES SHOWN ON THESE DRAWINGS ARE SCHEMATIC AND FOR REFERENCE ONLY. A STRUCTURAL EVALUATION OF THE SITE STRUCTURE, ANTENNA MOUNTINGS AND HARDWARE SHOULD BE PERFORMED AND RECOMMENDATIONS IMPLEMENTED PRIOR TO THE INSTALLATION OF THIS SCOPE OF WORK. THENCE, INFORMATION INDICATED IN THE STRUCTURAL ANALYSIS REGARDING FINAL APPURTENANCE/EQUIPMENT/CABLE ARRANGEMENT AND DETAILS SUPERCEDES THESE DRAWINGS.

EQUIPMENT NOTES


ALL RADIO EQUIPMENT PLACEMENT AND INSTALLATION IS BY AN EQUIPMENT SUPPLIER WHO IS
RESPONSIBLE FOR COORDINATING HIS WORK WITH THE WORK OF OTHERS AS IT RELATES TO THE
RADIO FOLIPMENT.

TENANT IMPROVEMENT NOTES

- 1. PROVIDE A PORTABLE FIRE EXTINGUISHER WITH A RATING OF NOT LESS THAN 2-A OF 2-A108C WITHIN 75 FEET OF TRAVEL DISTANCE TO ALL POTIONS OF THE BUILD OUT AREA DURING CONSTRUCTION
- 2. ANY ALTERATION TO EXISTING FIRE PROTECTION FACILITIES WILL REQUIRE CLEARANCE AND PERMITS FROM THE GOVERNING FIRE DEPARTMENT AND OTHER AGENCIES BY A LICENSED FIRE PROTECTION CONTRACTOR

ANTENNA NOTES

- 1. ANTENNA CONTRACTOR SHALL ENSURE THAT ALL ANTENNA MOUNTING PIPES ARE PLUMB.
- 2. COAXIAL FEEDER AND FIBER LENGTHS INDICATED ARE APPROXIMATE.
- ANTENNA COAXIAL FEEDERS AND ANTENNA JUMPERS SHALL BE COLOR CODED PER VERIZON REQUIREMENTS.
- 4. MULTI-PORT ANTENNAS: TERMINATE UNUSED ANTENNA PORTS WITH CONNECTOR CAP AND WEATHERPROOF THOROUGHLY. JUMPERS FROM TMA'S MUST TERMINATE TO OPPOSITE POLARIZATIONS IN EACH SECTOR.
- 5. CONTRACTOR MUST FOLLOW ALL MANUFACTURER'S RECOMMENDATIONS REGARDING THE INSTALLATION OF COAXIAL CARLES. CONNECTORS, AND ANTENNAS.
- 6. CONTRACTOR SHALL RECORD THE SERIAL#, SECTOR, AND POSITION OF EACH ANTENNA AND ACTUATOR INSTALLED AT THE ANTENNAS AND FURNISH THE INFORMATION TO VERIZON.
- 7. ANTENNA CONTRACTOR SHALL PERFORM A "TAPE DROP" MEASUREMENT TO CONFIRM/VALIDATE ANTENNA CENTERLINE (ACL) HEIGHT. CONTRACTOR SHALL SUBMIT A COMPLETED HEIGHT VERIFICATION FORM TO THE CONSTRUCTION MANAGER.
- ALL FIBER RUNS TO BE CONTAINED IN A SINGLE HYBRID DC POWER/FIBER CABLE FROM UPPER OVP TO LOWER OVP (COLOR CODE COAX JUMPERS ONLY).
- 9. WEATHERPROOF UNUSED TMA AND RADIO UNIT PORTS.
- 10. ALL ANTENNA AZIMUTHS TO BE FROM TRUE NORTH.

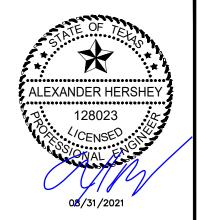

KGI WIRELESS, INC. TEXAS FIRM NO. F-15692 FIRM REGISTRATION RENEWAL 12/31/2021 PE LICENSE RENEWAL 06/30/2022



KGI WIRELESS, INC. ENGINEERING

805 LAS CIMAS PKWY BUILDING THREE, SUITE 370 AUSTIN, TX 78746 512.345.9595

SITE NAME
SAMUEL_PARK
LOCATION CODE

104821 SITE ADDRESS: 1101 E MAIN ST MESQUITE, TX 75149

THESE DRAWINGS ARE THE PROPERTY OF VERIZON WIRELESS. THEY ARE INTENDED FOR THE EXCLUSIVE USE OF THIS PROJECT ONLY. ANY RE-USE OF THESE PLANS (DRAWINGS) WITHOUT THE EXPRESS WRITTEN CONSENT OF VERIZON WIRELESS IS PROHIBITED.

ISSUED FOR: DATE
PERMITTING REV 0 04/01/2021
PERMITTING REV 1 08/31/2021


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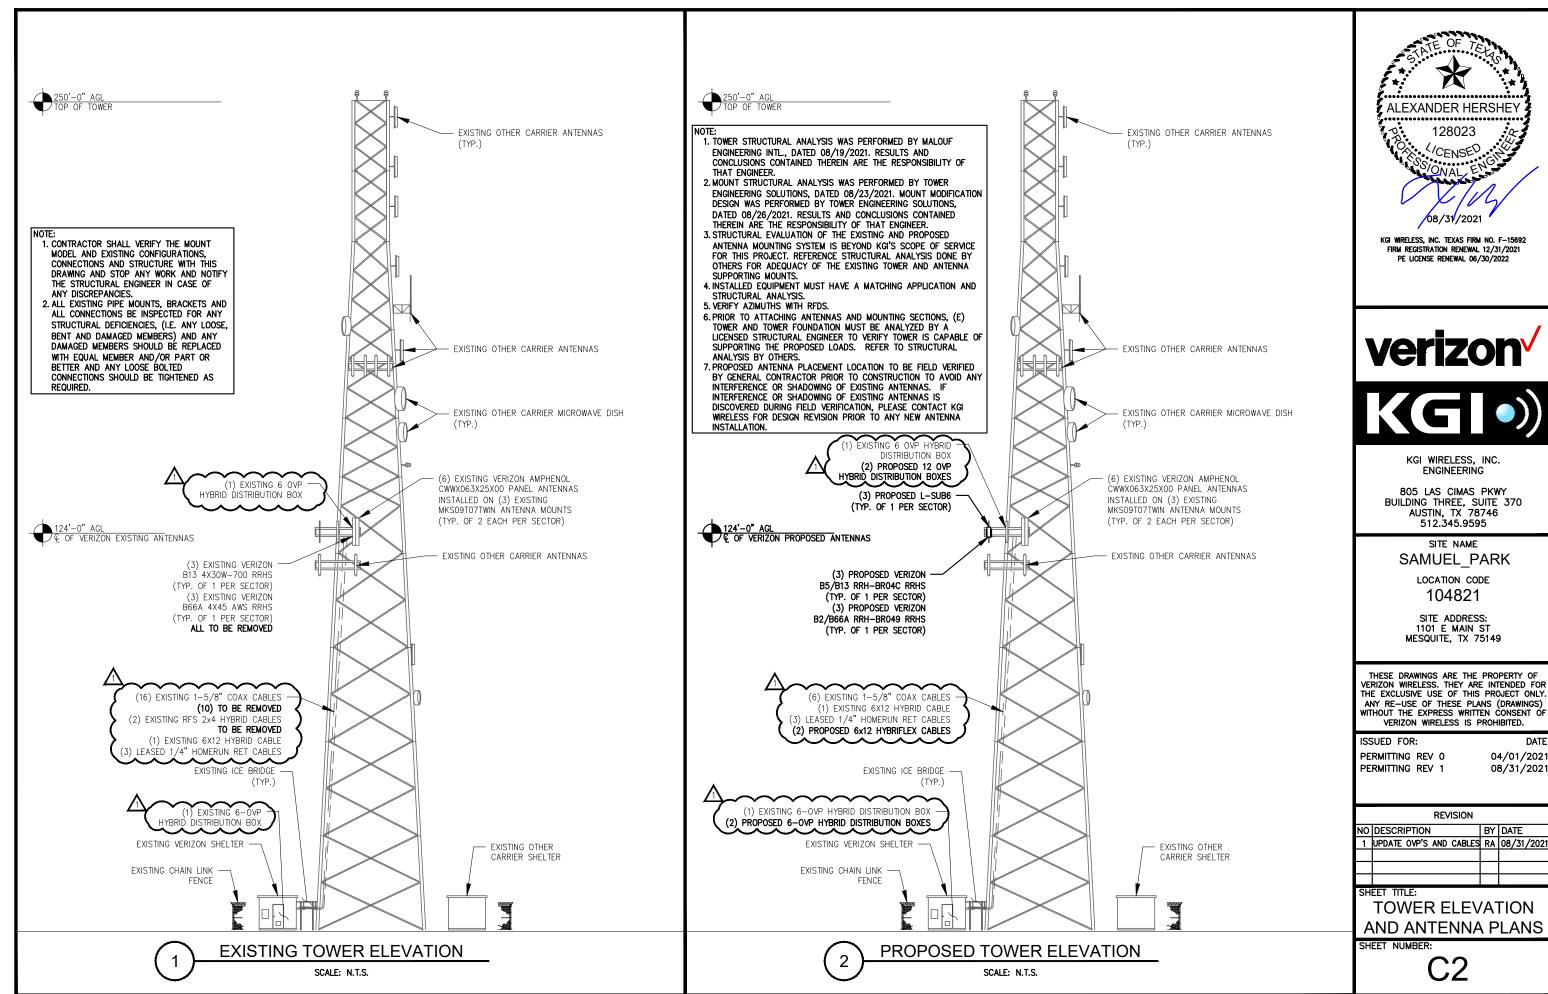
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GENERAL NOTES

SHEET NUMBER:

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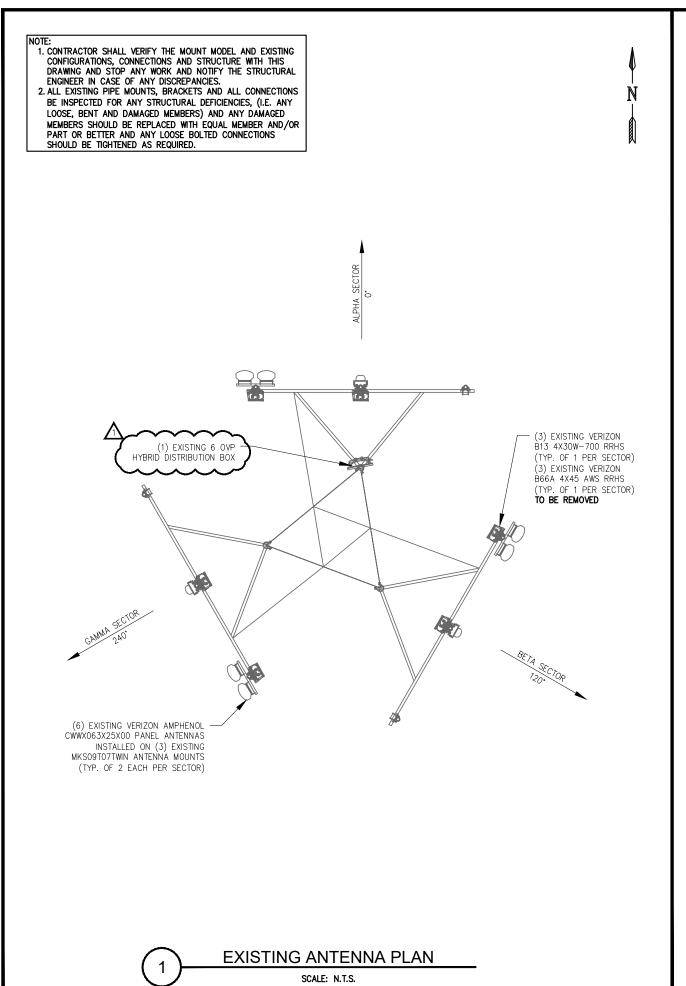




THE EXCLUSIVE USE OF THIS PROJECT ONLY. ANY RE-USE OF THESE PLANS (DRAWINGS) WITHOUT THE EXPRESS WRITTEN CONSENT OF

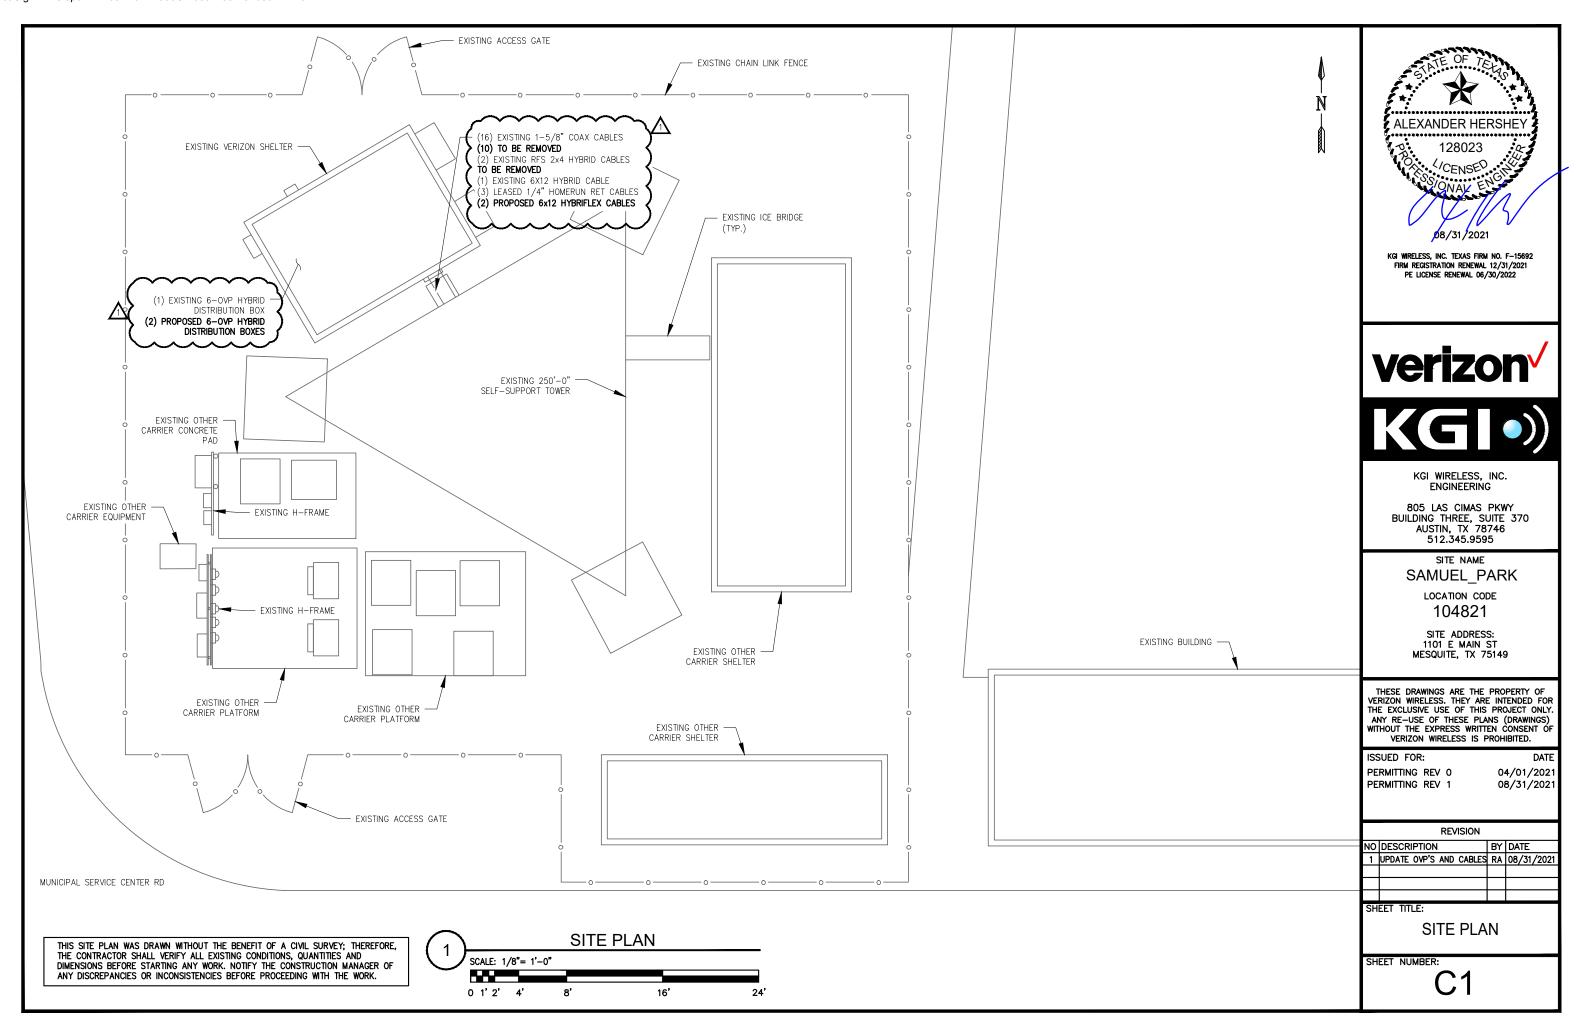			DATE
	UPDATE OVP'S AND CABLES	RA	08/31/202
1			


AND ANTENNA PLANS




NOTE:

1. CONTRACTOR SHALL VERIFY THE MOUNT MODEL AND EXISTING CONFIGURATIONS, CONNECTIONS AND STRUCTURE WITH THE ATTACHED SPECIFICATIONS AND STOP ANY WORK AND NOTIFY THE STRUCTURAL ENGINEER IN CASE OF ANY DISCREPANCIES.

MODIFICATION NOTE:
MOUNT REQUIRES MODIFICATION BEFORE ANY NEW EQUIPMENT IS INSTALLED. REFERENCE T.E.S. MOUNT MODIFICATION DRAWINGS DATED 03/23/2021.

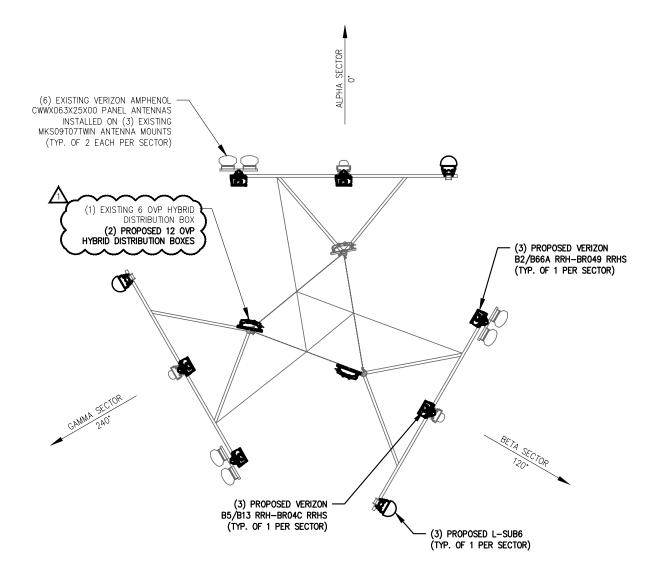

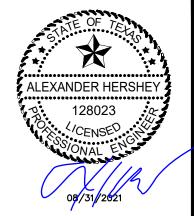

KGI WIRELESS, INC. TEXAS FIRM NO. F-15692 FIRM REGISTRATION RENEWAL 12/31/2021 PE LICENSE RENEWAL 06/30/2022

verizon'

KGI WIRELESS, INC. ENGINEERING

805 LAS CIMAS PKWY BUILDING THREE, SUITE 370 AUSTIN, TX 78746 512.345.9595

SAMUEL_PARK

LOCATION CODE 104821

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ISSUED FOR:
PERMITTING REV 0
PERMITTING REV 1

04/01/2021 08/31/2021

	REVISION				
NO	DESCRIPTION		DATE		
1	UPDATE OVP'S AND CABLES	RA	08/31/2021		

SHEET TITLE:

ANTENNA PLANS

SHEET NUMBER:

C3

 $\binom{2}{2}$

PROPOSED ANTENNA PLAN

2 **)**—

SCALE: N.T.S.

696-960 MHz

For use inside UNICELL modules

UNX-20-xx



CX063X25x00

X-Pol | Single Band VET Panel | 65° | 16.8 dBi

Ordering Options	Model Number			
Manual Electrical Tilt	CX063X25M00			
Remote Electrical Tilt AISG v1.1	CX063X25R00			
Remote Electrical Tilt AISG v2.0 / 3GPP	CX063X25G00			
Electrical Characteristics	696-960 MHz			
Frequency bands (MHz)	696	-806	806	-960
Polarization	±45°			
Horizontal beamwidth	70° 65°			
Vertical beamwidth	7.	4°	6.	9°
Gain	16.3	3 dBi	16.8	3 dBi
Electrical downtilt		0-1	0°	
Impedance		50	Ω	
VSWR		< 1.	5:1	
Upper sidelobe suppression		< -18 dB		
Front-to-back ratio		> 25		
In-band isolation		> 25		
Input power	2 x 500 W			
IM3 (2x20W carriers)	< -153 dBc			
Lightning protection	Direct Ground			
Operating temperature	-40° to +60° C (-40° to +140° F)			
Connector(s)	2 Ports / 7/16 DIN / Female / Bottom			
Mechanical Characteristics				
Dimensions Length x Width x Depth	2508 x 3	05 x 180 mm	98.7 x 12.0	x 7.1 in
Weight without mounting brackets: MET		15.9 kg		35.0 lbs
Weight without mounting brackets: RET		16.2 kg		35.7 lbs
Survival wind speed		241 km/hr		150 mph
Wind loads (160 km/hr or 100 mph)	Front: 930 N; S	Side: 550 N	Front: 209; Side	: 124 lbf
Remote Electrical Downtilt Control				
Remote Electrical Tilt (RET) Control	The remote control of the electrical tilt is managed by a module (MDCU) totally inserted at the bottom of the antenna. One single module controls individually the tilt of each band (no need of daisy chain cables between the bands). This module does not add any additional length at the bottom of the antenna. For RET control, the transparent cap must be in place and locked. The tilt angle indicator always remains visible and the antenna still has manual tilt control (manual override).			
RET Module Part Number (one per antenna)	MDCU-A0000 for Al (one unit included in			
	MDCU-G0000 for 30 (one unit included in	GPPP/AISG v2.0 protoc CX063X25G00)	col	
Important Installation Instructions	/// tilt adju	to operate RET contr stment indicator mus from the antenna.		
Mounting Options	Part Number Fits Pipe Diameter Weight			
3-Point Mounting Bracket Kit	MKS09P02	50-115 mm	2.0-4.5 in	4.1 kg 9 lbs
3-Point Mounting & Downtilt Bracket Kit	MKS09T02	50-115 mm	2.0-4.5 in	6.4 kg 14 lbs
Tri-Sector UNICELL Options				
For use incide LINICELL modules	LINIX 20 vov			

Quoted performance parameters are provided to offer typical or range values only and may vary as a result of normal manufacturing and operational conditions. Extreme operational conditions and/or stress on structural supports is beyond our control. Such conditions may result in damage to this product. Improvements to product may be made without notice.

1 of 3 www.amphenol-antennas.com



1710-2170 MHz

W85-19-x28

Single Band | Panel Antenna | X-Pol | 85° | 18.3 dBi | Variable Tilt

- Single band, X-Pol, variable tilt, panel antenna
- MET and RET versions, AISG v1.1 or 3GPP/AISG v2.0
- External RET unit

Wind Load at 161 km/hr (100 mph)

Ordering	Options	Model Number			
When ord	ering, replace "x" in the model nu	mber with one of the option	ns listed below.		
Manual El	ectrical Tilt	W85-19-M28			
Remote E	lectrical Tilt AISG v1.1	W85-19-R28			
Remote E	lectrical Tilt 3GPP/AISG v2.0	W85-19-R28G			
Mounting	bracket kits and other accessories	are ordered separately.			
Electrical	Characteristics	1710-2170 MHz			
Frequency	y Bands	1710-1880 MHz	1850-1990 MHz	1900-2170 MHz	
Polarizatio	on		±45°		
Horizonta	l Beamwidth	85°	85°	85°	
Vertical E	Beamwidth	5.3°	5.1°	4.7°	
Gain		17.5 dBi	17.8 dBi	18.3 dBi	
Electrical Downtilt			2-8° Variable Electrical Tilt		
Impedano	e	50Ω			
VSWR		< 1.4:1			
Upper Sid	lelobe Suppression		< -18 dB		
Front-to-E	Back Ratio		> 25 dB		
Inter-Port	Isolation		> 28 dB		
IM3 (2x20	W Carriers)		< -153 dBc		
Input Pow	ver		2 x 200W		
Total Num	ber of Connectors / Type / Location	2 Po	rts / 7/16-DIN Female / E	Bottom	
Diplexed			No		
Operating	Temperature	-40° to +60° C (-40° to +140° F)			
Mechanic	al Characteristics				
MET	Dimensions (L x W x D)	1935 x 170 x 10	00 mm	76.2 x 6.7 x 3.9 in	
Antenna	Weight without Mounting Brackets	11	.0 kg	24.0 lbs	
RET	Dimensions (L x W x D)	2105 x 170 x 10	00 mm	82.9 x 6.7 x 3.9 in	
Antenna	Weight without Mounting Brackets	ackets 11.7 kg 25.5 lbs			
Survival W	/ind Speed	24	41 km/hr	150 mph	

Front: 402 N Side: 234 N



Front: 90 lbf Side: 53 lbf

REV081116O 1 of 4 www.amphenol-antennas.com

EQUIPMENT SPECIFICATIONS AND INFORMATION

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KGI WIRELESS, INC. ENGINEERING

805 LAS CIMAS PKWY BUILDING THREE, SUITE 370 AUSTIN, TX 78746 512.345.9595

> SITE NAME SAMUEL_PARK

LOCATION CODE 104821

SITE ADDRESS: 1101 E MAIN ST MESQUITE, TX 75149

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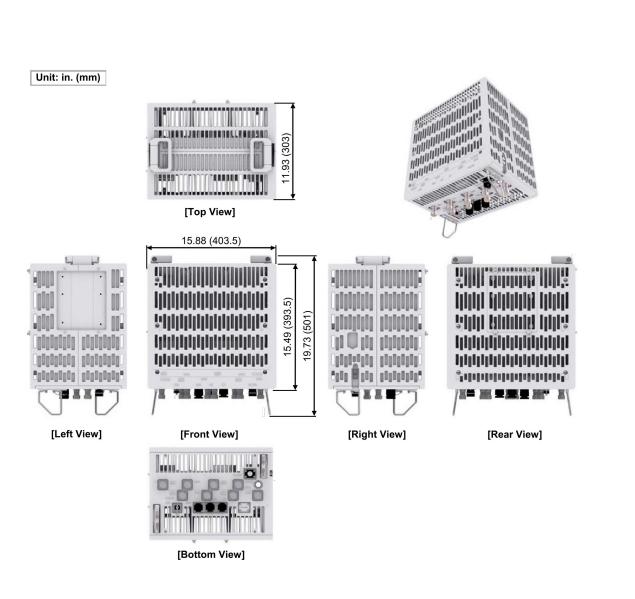
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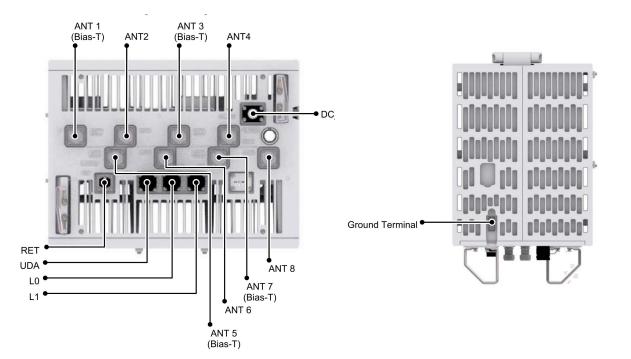
ANTENNA SPECIFICATIONS

SHEET NUMBER:

RF1

EXISTING ANTENNA SPECS SCALE: N.T.S.





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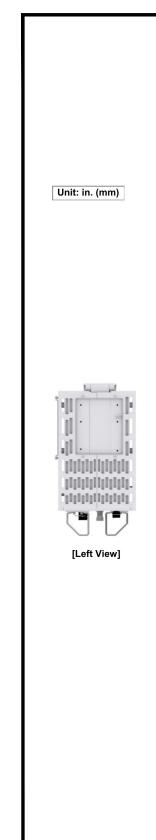
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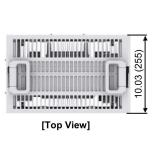
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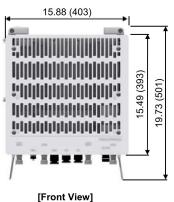
PROPOSED EQUIPMENT SPECS

SHEET NUMBER:

RF2









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[Bottom View]







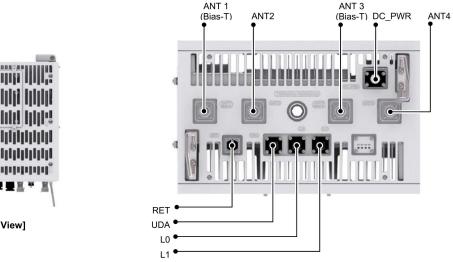

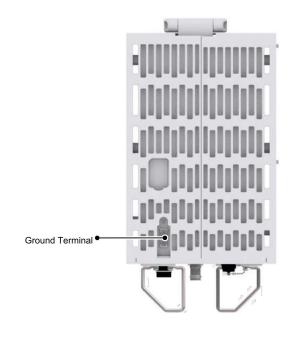

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> SITE NAME SAMUEL_PARK LOCATION CODE

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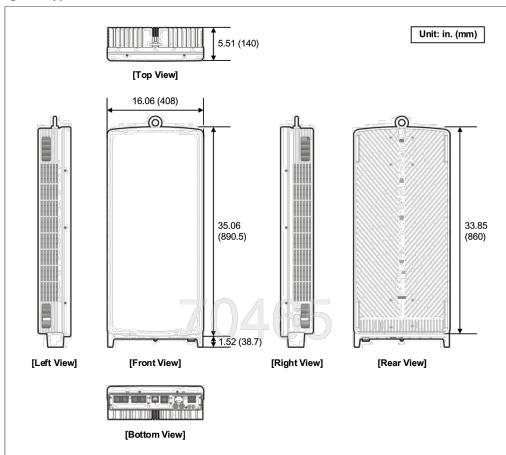


Confidential

SAMSUNG

The following figures depict the physical views of the MT6407-77A.

Figure 1. Appearance



SAMSUNG

Specifications

Confidential

Specifications

The following table displays the main specifications of the MT6407-77A.

Table 2. Specifications

Item	Description
Air Technology	NR
Frequency	3700~3980 MHz
IBW	280 MHz
OBW	200 MHz
Carrier Bandwidth	20/40/60/80/100 MHz
Number of Carriers	2 carriers (Contiguous, Non-Contiguous) NR 1C: 20/40/60/80/100M NR 1CC+1CC 20/40/60/80/100M + 20/40/60/80/100M
Layer	DL: 16 Layers UL: 16 RX (8 Layers)
RF Chain	64T64R
Antenna Configuration	4 V16H with 192 AE
EIRP	78.5 dBm (53 dBm + 25.5 dBi)
Conductive Power	200 W
Spectrum Analyzer	TX/RX support
Modulation	DL 256QAM support, (DL 1024QAM with 1~2 dB power back-off)
Function Split	DL/UL Option 7-2x
Fronthaul Interface	CPRI, eCPRI
Optic Interface	4 ports (25 Gbps × 4), SFP28, single mode, Bi-di (Option: Duplex), 15 km
External Alarm	4 RX
Input Power	-48 VDC (-38 to -57 VDC)
Power Consumption[Note]	 1,395 W @ 100 % RF load, room temperature 1,428 W @ 100 % RF load, all temperature 1,003 W @ 40% RF load, room temperature
Size (WHD)	408 × 890.5 × 140 mm (16.06 × 35.06 × 5.51 inch)
Volume	50.9 L
Weight	37 kg or less
Operating Temperature	-40-55 °C (w/o solar load)
Operating Humidity	5~100 % RH RH, non-condensing, not to exceed 30 g/m3 absolute humidity.
Waterproof/Dustproof	IEC 60529 IP65
Earthquake	Telcordia GR-63-Core, Zone4
Cooling	Natural convection
Mounting Options	Pole, wall

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EQUIPMENT SPECIFICATIONS AND INFORMATION

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EQUIPMENT SPECS

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MOUNT MODIFICATION DRAWINGS

PROPOSED CARRIER: VERIZON

CARRIER SITE NUMBER: 104821-VZW CARRIER SITE NAME: SAMUEL_PARK

COORDINATES (LATITUDE: 32.768730°, LONGITUDE: -96.586380°)

FUZE ID # 16229054

Contractor PMI Requirements				
PMI Accessed At https://pmi.vzwsmart.com				
Smart Tool Vendor Project Number	10096019	Post MOD Analysis Report Project Number	10096019	
VzW Location Code (PSLC)	104821	Report Dated	8/23/2021	

VzW APPROVED SMART KIT VENDORS						
Refer to Mount Modification Drawings Page for VzW SMART KIT Approved Vendors						

SHEET	SHEET TITLE	REV
ST-1	TITLE SHEET	0
SBOM	BILL OF MATERIALS	0
SGN-1	GENERAL NOTES	0
SCF-1	CLIMBING FACILITY DETAILS	0
SS-1	ANTENNA MOUNT MODIFICATION DETAILS	0
SS-2	STANDARD DETAILS	0
SS-3	STANDARD DETAILS	0
SS-4	STANDARD DETAILS	0
SS-5	STANDARD DETAILS	0
SS-6	MOUNT PHOTOS	0
-	SPECIFICATION SHEETS	

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1320 GREENWAY DRIVE, SUITE 600
IRVING, TX 75038
PH: (972) 483–0607

verizon/

TES JOB NO: 10096019

CUSTOMER SITE NO:
104821-VZW
CUSTOMER SITE NAME:
SAMUEL_PARK
1101 E MAIN ST
MESQUITE, TX 75149

TOWER ENGINEERING SOLUTIONS, LLC TEXAS REGISTERED ENGINEERING FIRM F-15688

Exp.09/30/2021



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					BILL OF MATER	IALS					
ANTITY UNTED	QUANTITY PROVIDED	PART NUMBER		DESCRIPTIONS			SHEET LIST	PIECE WEIGHT (LBS)	WEIGHT (LB)		NOTES
				MATERIAL & HARDWA	RE						
4	4	VZWSMART-MSK7	ANGLE TO ANGLE CROSSOVER			SS-	-1, VZWSMART-MSK7	7.0	28.0		Galvanized
								 			
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								 	-	<u> </u>	
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		DV 445 CC 105		WING ITEMS ARE "CUSTO	OM" PARTS			120.00	270.0		CALVANIZED
2	3 2	PV-MD-CS-18R P40-238X072	PERFECT VISION MICROWAVE STRUT SUPPORTING PIPE 2 SCH40 (2.375" OD X 0.154" THK) X 6'-0"				SS-1, SS-2 SS-1, SS-5	120.00 22.61	378.0 45.2		GALVANIZED LENGTH TO BE DETERMINED IN FIELD)
3	3	P40-238X072 P40-238X174	PIPE 2 SCH40 (2.375 OD X 0.154 THK) X 14'-6				SS-1, SS-5 SS-3	0.00	0.0		LENGTH TO BE DETERMINED IN FIELD)
6	6	PL375-4511	PL 3/8" X 4 1/2" X 11" A36				SS-3	0.00	0.0		GALVANIZED
6	6	V-CLAMP	PL 1/2" X 4 1/4" X 8 5/8" A36				SS-3	0.00	0.0		GALVANIZED
6	6	BP2-875	PL 1/4" X 2" X 8 3/4" A36 BENT PLATE				SS-3	0.00	0.0		GALVANIZED
24	26		BOLT 5/8" X 6" FUL THREAD SAE GR 5				SS-3	0.00	0.0		k LKW-EA GALVANIZED
5	7		BOLT 5/8" X 4 1/4" A325				SS-3	0.00	0.0		& LKW-EA GALVANIZED
6	7		BOLT 5/8" X 2" A325			SS-3	0.00	0.0	(1) HHN 8	k LKW-EA GALVANIZED	
									+		
								 			
								 			
								<u> </u>			
								<u> </u>			
								 			
							TOTAL WEIGHT (L	BS) =	451.2		
				V	zW Mount Modification Kits -	· Approved Vendor	<u>;</u>				
								1 —			
		PerfectVis		·						Sabre Industri	
tact:		Wireless Sales	wirelesssales@perfect-vision.com	Contact:	Kent Ramey		rositellc.com	Cont		Angie Welch	<u>akwelch@sabreindustries.com</u>
ne Nu	nber	844.887.6723		Phone Number	(O) 706.335.7045		.982.9788	1 1	ne Number	866.428.6937	
site			www.perfect-vision.com	Website		<u>metrositefa</u>	bricators.com	Web	bsite		www.sabresitesolutions.com
								┧┕			
		SitePro	1		CommScope			1			
tact:		Paula Boswell	paula.boswell@valmont.com	Contact:	Salvador Anguiano		o@commscope.com	1			
	nber	972.236.9843	padia.Noswene-vaniloni.com	Phone Number	817.304.7492	<u>Juitaudi Aliguidii</u>	20 commiscope.com				
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one Nu ·bsite			www.sitepro1.com	Website		www.com	mscope.com	1			

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RIVE, SUITE 600
75038

O19 SITE NO: -VZW NAME: .PARK

AIN ST X 75149 SOLUTIONS, LLC ENGINEERING FIRM

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ATERIALS

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SBOM

REV #:

modifications will be reviewed as a part of the Desktop PMI completed by the SMART tool vendor. It will be required that the VzW kits specified are utilized in the modification. All materials required for the designed modifications but not list in this sheet are assumed to be provided by the contractor. All parts are galvanized unless noted otherwise.

GENERAL NOTES

- ALL WORK SHALL COMPLY WITH THE ANSI/TIA-222-H, ANSI/ASSP A10.48, AND ANY OTHER GOVERNING BUILDING CODES AND OSHA SAFETY REGULATIONS.
- 2. ALL WORK INDICATED ON THE DRAWINGS SHALL BE PERFORMED BY QUALIFIED CONTRACTORS EXPERIENCED IN TELECOMMUNICATIONS TOWER, POLE AND FOUNDATION CONSTRUCTION.
- 3. THE CONTRACTOR SHALL BE RESPONSIBLE FOR THE DESIGN AND FABRICATION OF ALL MISCELLANEOUS PARTS (SUCH AS SHIMS), TEMPORARY SUPPORTS, AND GUYINGS, ETC., PER ANSI/ASSP A10.48, TO COMPLETE THE ASSEMBLY AS SHOWN IN THE DRAWINGS.
- 4. CONTRACTOR SHALL PROCEED WITH THE INSTALLATION WORK CAREFULLY SO THE WORK WILL NOT DAMAGE ANY EXISTING CABLE, EQUIPMENT OR THE STRUCTURE.
- 5. THE USE OF GAS TORCH OR WELDER, ARE NOT ALLOWED ON ANY TOWER STRUCTURE WITHOUT THE CONSENT OF THE TOWER OWNER.
- 6. GENERALLY THE CONTRACTOR IS RESPONSIBLE TO CONDUCT AN ONSITE VISIT SURVEY OF THE JOB SITE AFTER AWARD, AND REPORT ANY ISSUES WITH THE SITE TO **TES** BEFORE PROCEEDING CONSTRUCTION.
- 7. TEMPORARILY RELOCATE ANY EXISTING COAX ATTACHED TO THE LEGS AND/OR ANY OTHER MEMBERS WHERE OBSTRUCTION WITH THE PROPOSED MODIFICATION MAY OCCUR.
- 8. IT IS THE RESPONSIBILITY OF THE GC TO VERIFY THAT THERE IS NO INTERFERENCES (WITH SAFETY CLIMB BRACKETS, TRANSMISSION LINES, ETC.) PRIOR TO MOBILIZATION AND INSTALLATION OF THESE MODIFICATIONS.
- 9. PLEASE NOTIFY TES IMMEDIATELY IF ANY INSTALLATION ISSUES OCCUR RELATED TO THIS DRAWING @ 972-483-0607 OR EMAIL-TESORDERS@TESTOWER.US

FABRICATION

- 1. ALL STEEL SHALL MEET OR EXCEED THE MINIMUM STRENGTH AS SPECIFIED IN THE DRAWINGS. IF YIELD STRENGTH WAS NOT NOTED IN THE DRAWINGS, CONTRACTORS SHALL CONTACT TES FOR DIRECTION.
- 2. ALL FIELD CUT EDGES SHALL BE GROUND SMOOTH. ALL FIELD CUT AND DRILLED SURFACES SHALL BE REPAIRED WITH A MINIMUM OF TWO COATS OF ZINGA COLD GALVANIZING COMPOUND PER ASTM A780 AND MANUFACTURER'S RECOMMENDATIONS.

<u>WELDING</u>


- 1. ALL WELDING SHALL BE PERFORMED BY AWS CERTIFIED WELDERS AND IN ACCORDANCE WITH THE LATEST EDITION OF THE AWS WELDING CODE D1.1. ALL ELECTRODES TO BE LOW HYDROGEN, MATCHING FILLER METAL, PER AWS D1.1, UNO. (E70XX UNLESS NOTED OTHERWISE).
- 2. PRIOR TO FIELD WELDING GALVANIZED MATERIAL, CONTRACTOR SHALL GRIND OFF GALVANIZING APPROX. 0.5" BEYOND THE PROPOSED FIELD WELD SURFACES.
- 3. ALL WELDS SHALL BE INSPECTED VISUALLY. A MINIMUM OF 25% OF WELDS SHALL BE INSPECTED WITH DYE PENETRANT OR MAGNETIC PARTICLE TO MEET THE ACCEPTANCE CRITERIA OF AWS D1.1. 100% OF WELDS SHALL BE INSPECTED IF DEFECTS ARE FOUND.
- 4. WELD INSPECTIONS SHALL BE PERFORMED BY AN AWS CERTIFIED WELD INSPECTOR.
- 5. AFTER INSPECTION, ALL FIELD WELDED SURFACES SHALL BE REPAIRED WITH A MINIMUM OF TWO COATS OF ZINGA COLD GALVANIZING COMPOUND PER ASTM A780 AND MANUFACTURER'S RECOMMENDATIONS.

BOLTED ASSEMBLIES AND TIGHTENING OF CONNECTIONS

- 1. ALL HIGH STRENGTH BOLTS SHALL CONFORM TO THE PROVISIONS OF THE SPECIFICATIONS FOR STRUCTURAL JOINTS USING A325 OR A490 BOLTS AS APPROVED BY THE RCSC.
- 2. FLANGE BOLTS SHALL BE TIGHTENED BY THE AISC "TURN-OF-THE-NUT" METHOD. THE FOLLOWING TABLE SHOULD BE USED FOR THE "TURN-OF-THE-NUT" TIGHTENING.
- 3. SPLICE BOLTS AND ALL OTHER BOLTS IN BEARING TYPE CONNECTIONS SHALL BE TIGHTENED TO A SNUG-TIGHT CONDITION.
- 4. THE SNUG-TIGHT CONDITION IS DEFINED AS THE TIGHTNESS ATTAINED BY EITHER A FEW IMPACTS OF AN IMPACT WRENCH OR THE FULL EFFORT OF AN IRONWORKER WITH AN ORDINARY SPUD WRENCH TO BRING THE CONNECTED PLIES INTO FIRM CONTACT.
- 5. FOR THREADED ROD CONNECTIONS, TRIM EXCESS THREADED ROD TO NO MORE THAN 3" PAST THE NUT AND COAT WITH ZINGA COLD GALVANIZING COMPOUND.

VERIFICATION AND INSPECTION

1. IF APPLICABLE, VERIFICATION INSPECTION TO BE PERFORMED SHALL BE IN ACCORDANCE TO IBC-2018 SECTION 1705.2 FOR STEEL CONSTRUCTION AND TABLE 1705.3 FOR CONCRETE CONSTRUCTION.

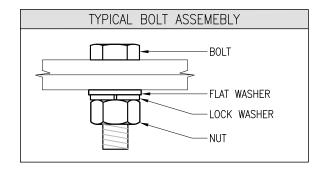

NOTES

- ALL DIMENSIONS REPRESENTED IN THIS SHEET ARE AISC MINIMUM REQUIREMENTS. CONTRACTOR SHALL VERIFY EXISTING CONDITIONS IN FIELD AND NOTIFY ENGINEER IF DISTANCES ARE LESS THAN THOSE PROVIDED.
- THE DIMENSIONS PROVIDED ARE MINIMUM REQUIREMENTS. ACTUAL DIMENSIONS OF PROPOSED MEMBERS WITHIN THESE DRAWINGS MAY VARY FROM THE AISC MINIMUM REQUIREMENTS.
- SHORT SLOT HOLES SHALL ONLY BE USED WHEN DEPICTED IN THE DRAWINGS.
- 4. MATCH EXISTING GAGES WHEN APPLICABLE, UNLESS MINIMUM EDGE DISTANCE ARE COMPROMISED.

TABLE 8.2 NUT ROTATION FROM SNUG-TIGHT CONDITION FOR TURN-OF-NUT PRETENSIONING a,b


	DISPOSITION OF OUTER FACE OF BOLTED PARTS					
BOLT LENGTH ^C	BOTH FACES NORMAL TO BOLT AXIS	ONE FACE NORMAL TO BOLT AXIS, OTHER SLOPED NOT MORE THAN 1:20 ^d	BOTH FACES SLOPED NOT MORE THAN 1:20 FROM NORMAL TO BOLT AXIS ^d			
NOT MORE THAN 4d _b	1/3 TURN	1/2 TURN	2/3 TURN			
MORE THAN 4d _b BUT NOT MORE THAN 8d _b	1/2 TURN	2/3 TURN	5/6 TURN			
MORE THAN 8d _b BUT NOT MORE THAN 12d _b	2/3 TURN	5/6 TURN	1 TURN			

ONUT ROTATION IS RELATIVE TO BOLT REGARDLESS OF THE ELEMENT (NUT OR BOLT) BEING TURNED. FOR REQUIRED NUT ROTATIONS OF 1/2 TURN AND LESS, THE TOLERANCE IS PLUS OR MINUS 30 DEGREES; FOR REQUIRED NUT ROTATIONS OF 2/3 TURN AND MORE. THE TOLERANCE IS PLUS OR MINUS 45 DEGREES.

SPECIFICATION FOR STRUCTURAL JOINTS USING ASTM A325 OR A490 BOLTS, JUNE 30, 2004 RESEARCH COUNCIL ON STRUCTURAL CONNECTIONS

NOMINAL HOLE DIMENSIONS						
BOLT DIAMETER	STANDAF	RD HOLE	SHORT SLOT			
1/2"	9/	16"	9/16" X 11/16"			
5/8"	11/16"		11/16 X 7/8"			
3/4"	13/	′16"	13/16" X 1"			
7/8"	15/16"		15/16" X 1 1/8"			
1"	1 1/16"		1 1/16" X 1 5/16"			
	BOLT EDGE /	AND SPACING				
BOLT DIAMETER	MIN EDGE	SPACING	MIN.			
1/2"	7/8"	1 1/2"	EDGE			
5/8"	1 1/8"	1 7/8"				
3/4"	1 1/4"	2 1/4"				
7/8"	1 1/2"	2 5/8"				
1"	1 3/4"	3"				

WORKABLE GAGES						
ANGLE SIZE	GAGE	GAGE I				
1 3/4"	1"					
2"	1 1/8"					
2 1/2"	1 3/8"					
3"	1 3/4"					
3 1/2"	2"]]				
4"	2 1/2"					

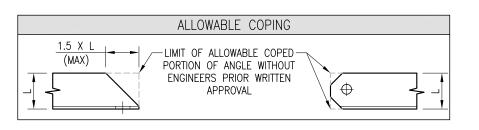

((H)) ES

Tower Engineering Solutions
1320 GREENWAY DRIVE, SUITE 600
IRVING, TX 75038

PH: (972) 483-0607

verizon

TES JOB NO: 10096019

CUSTOMER SITE NO: 104821-VZW CUSTOMER SITE NAME: SAMUEL_PARK

1101 E MAIN ST

MESQUITE, TX 75149

TOWER ENGINEERING SOLUTIONS, LLC
TEXAS REGISTERED ENGINEERING FIRM
F-15688

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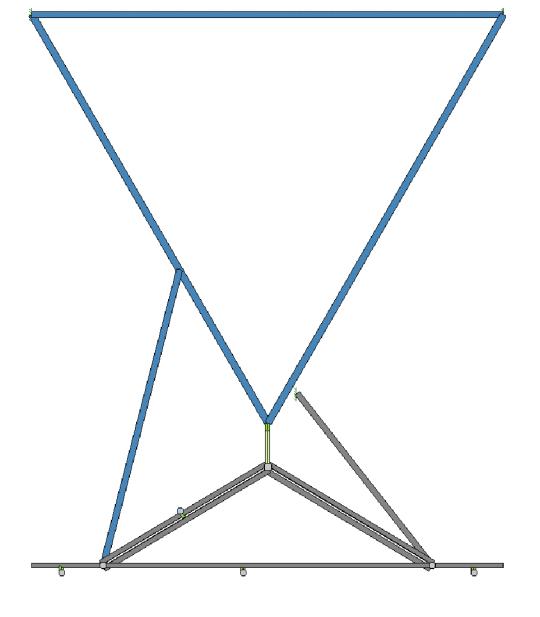
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REV #:

^b APPLICABLE ONLY TO JOINTS IN WHICH ALL MATERIAL WITHIN THE GRIP IS STEEL.

WHEN THE BOLT LENGTH EXCEEDS 12db, THE REQUIRED NUT ROTATION SHALL BE DETERMINED BY ACTUAL TESTING IN A SUITABLE TENSION CALIBRATOR THAT SIMULATES THE CONDITIONS OF SOLIDLY FITTING STEEL.

d BEVELED WASHER NOT USED.





PICTURE OF SAFETY CLIMB

NO SAFETY CABLE OBSERVED IN THE TOWER

((H))

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1320 GREENWAY DRIVE, SUITE 600
IRVING, TX 75038
PH: (972) 483-0607

verizon /

TES JOB NO: 10096019

CUSTOMER SITE NO: 104821-VZW CUSTOMER SITE NAME:

SAMUEL_PARK 1101 E MAIN ST MESQUITE, TX 75149

TOWER ENGINEERING SOLUTIONS, LLC TEXAS REGISTERED ENGINEERING FIRM F-15688

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CLIMBING FACILITY DETAILS

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NOTE:
1. INSTALL SHALL NOT CAUSE HARM TO THE STRUCTURE, CLIMBING FACILITY, SAFETY CLIMB OR ANY SYSTEM INSTALLED ON THE STRUCTURE.

MOUNT MODIFICATION SCHEDULE SL. NO. REFERENCE SHEET NO MOUNT MODIFICATION DESCRIPTION INSTALL NEW PERFECT VISION MICROWAVE STRUT SUPPORT FACE MOUNT KIT SS-2 (PV-MD-CS-18R) 2 INSTALL NEW TIE BACK PIPE. SS-3 INSTALL NEW VZWSMART ANGLE TO ANGLE CROSSOVER VZWSMART-MSK7, SS-5 VZWSMART-PIPE, SS-1, SS-5 INSTALL NEW 2" PST RAYCAP MOUNT PIPE (P40-238X072), (1) FOR (2) SECTOR ONLY FIELD CUTTING AND FIELD DRILLING MAY BE NECESSARY TO ACHIEVE THE REQUIRED DIMENSIONS FOR THREADED ROD CONNECTIONS, TRIM EXCESS THREADED ROD TO NO MORE THAN 3" PAST THE NUT AND COAT WITH ZINGA COLD GALVANIZING COMPOUND. IF EXISTING TOWER IS PAINTED, CONTRACTOR TO VERIFY WITH TOWER OWNER IF NEW MODIFICATION MEMBERS ARE TO BE PAINTED TO MATCH EXISTING TOWER COLOR. THE CONTRACTOR SHALL BE RESPONSIBLE FOR THE CLEAN-UP, REMOVAL AND DISPOSAL OF EXCESS MATERIALS USED AND REMOVED FROM THE STRUCTURE AT THE COMPLETION OF THE PROJECT. MEMBERS IN BLUE COLOR ARE NEW REINFORCEMENTS AND MEMBERS IN AQUA COLOR (IF SHOWN) ARE RELOCATED MEMBERS 16'-0" (REF) (TYP) 6'-0" ±3" 3'-0" ±3" ISOMETRIC VIEW EXISTING ANTENNA MOUNT @ 124' ELEV. (MODIFICATION IS TYPICAL FOR ALL (3) SECTORS)

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SAMUEL_PARK

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ANTENNA MOUNT MODIFICATION DETAILS


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SS-1


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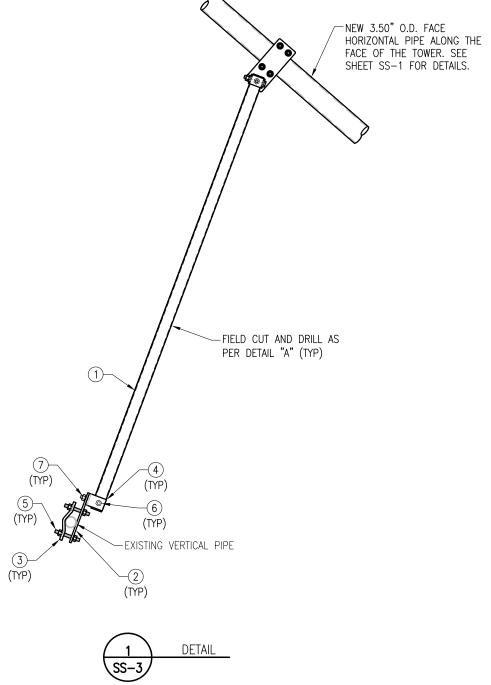



BY DATE

MG 08/26/21

REV #:

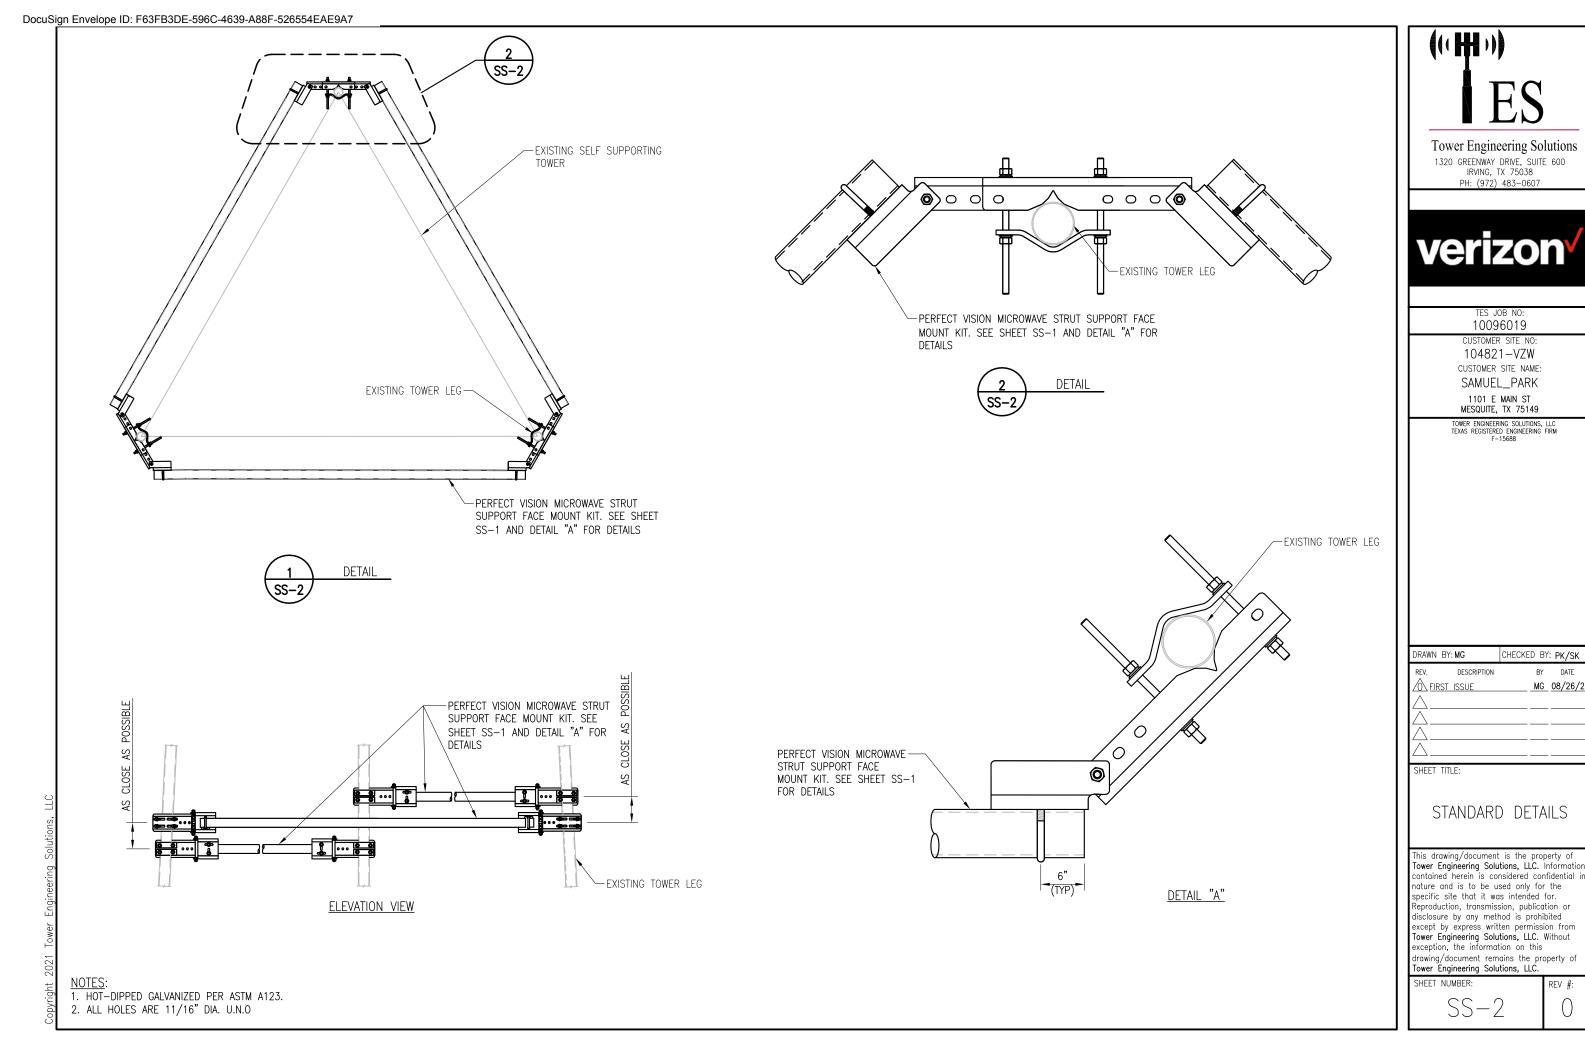

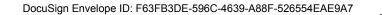

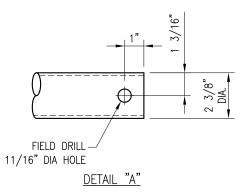

ITEM NO.	QTY.	PART NO.	DESCRIPTIONS
1	3	P40-238X174	PIPE 2 SCH40 (2.375" OD X 0.154" THK) X 14'-6" LONG
2	6	PL375-4511	PL 3/8" X 4 1/2" X 11" A36
3	6	V-CLAMP	PL 1/2" X 4 1/4" X 8 5/8" A36
4	6	BP2-875	PL 1/4" X 2" X 8 3/4" A36 BENT PLATE
5	24		BOLT 5/8" X 6" FUL THREAD SAE GR 5
6	6		BOLT 5/8" X 4 1/4" A325
7	6		BOLT 5/8" X 2" A325

((HH))

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TES JOB NO: 10096019 CUSTOMER SITE NO: 104821-VZW CUSTOMER SITE NAME: SAMUEL_PARK 1101 E MAIN ST MESQUITE, TX 75149

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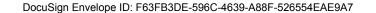
SS-3


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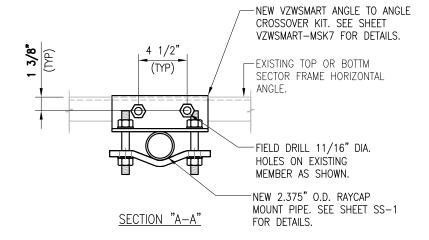
1. HOT-DIPPED GALVANIZED PER ASTM A123.

2. ALL HOLES ARE 11/16" DIA. U.N.O

11/16" DIA HOLE





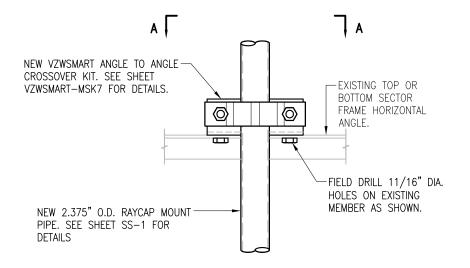



NOTES

1. HOT-DIPPED GALVANIZED PER ASTM A123.

2. ALL HOLES ARE 11/16" DIA. U.N.O

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NOTE: EXISTING RRUS/EQUIPMENT MAY BE RELOCATED ALONG THE MEMBER TO ACCOMMODATE THE

INSTALLATION OF NEW MOUNT MODIFICATION



-EXISTING ANTENNA MOUNT

@ 124' ELEV

PHOTO 2



PHOTO 1



PHOTO 3



PHOTO 4

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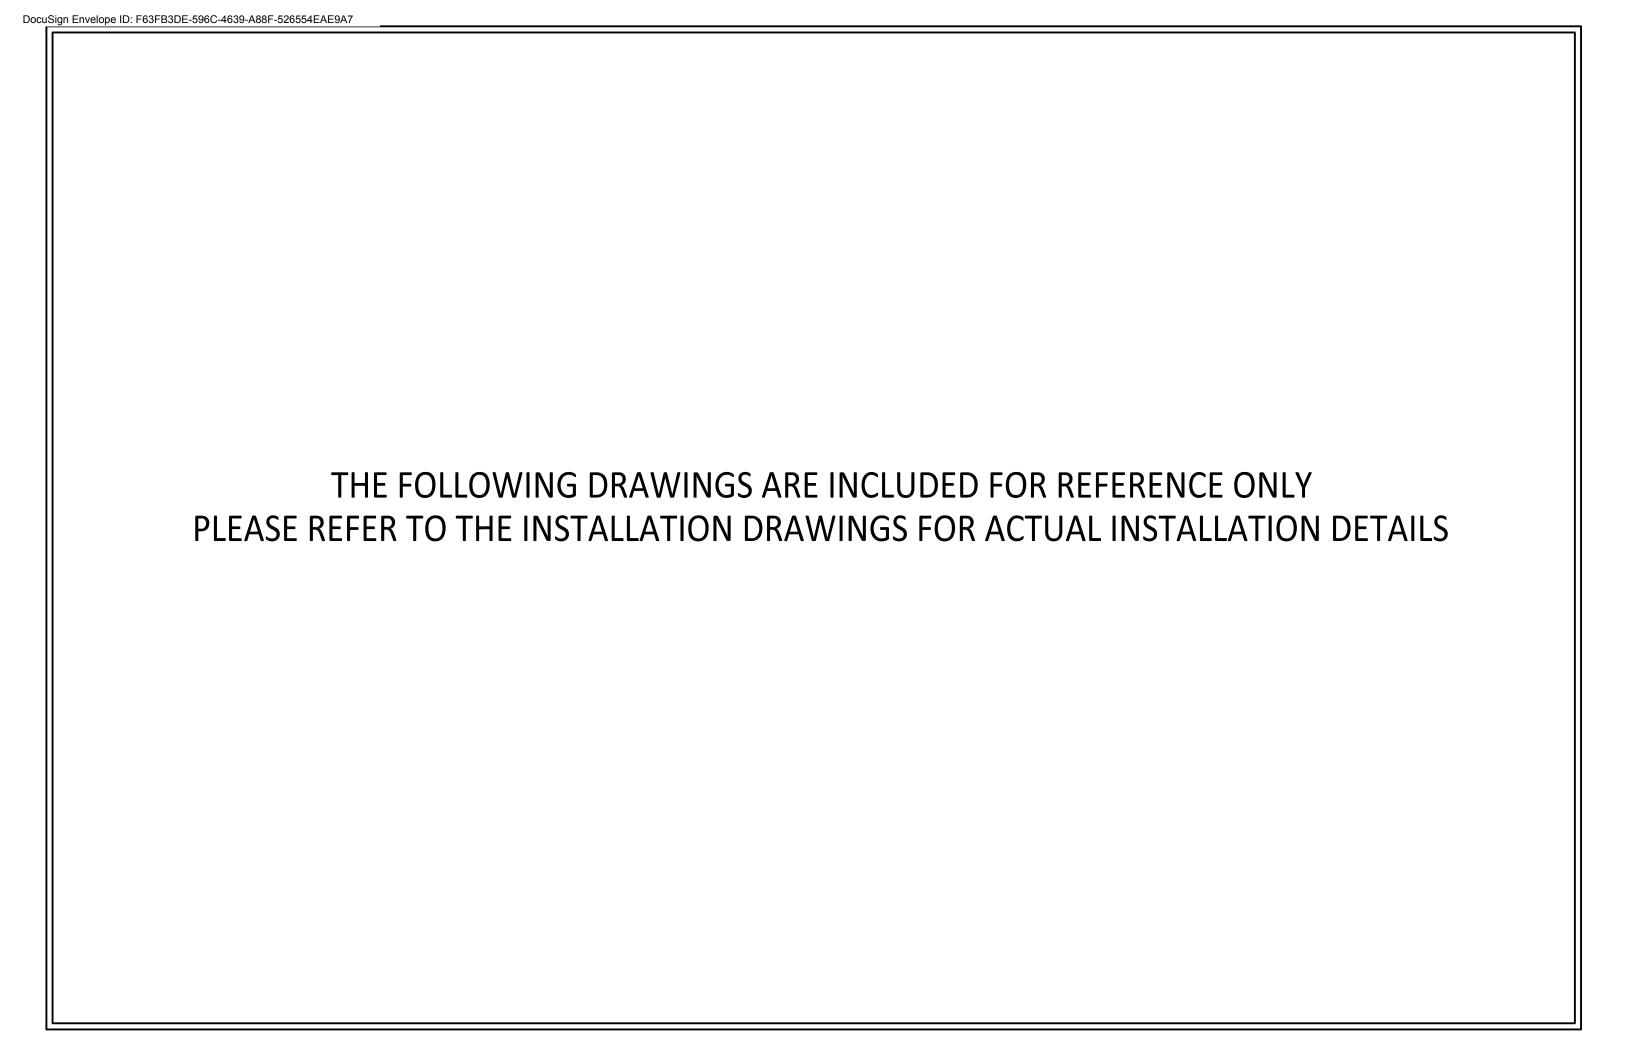
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MOUNT PHOTOS


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SS-6



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VZWSMART Standard Pipe			
VZWSMART Number	Size	Length	
P40-238X048	PIPE 2 SCH40 (2.375" OD x 0.154" THK)	48"	
P40-238X072	PIPE 2 SCH40 (2.375" OD x 0.154" THK)	72"	
P40-238X096	PIPE 2 SCH40 (2.375" OD x 0.154" THK)	96"	
P40-238X120	PIPE 2 SCH40 (2.375" OD x 0.154" THK)	120"	
P40-238X126	PIPE 2 SCH40 (2.375" OD x 0.154" THK)	126"	
P40-238X150	PIPE 2 SCH40 (2.375" OD x 0.154" THK)	150"	
P40-238X174	PIPE 2 SCH40 (2.375" OD x 0.154" THK)	174"	
P40-278X048	PIPE 2.5 SCH40 (2.875" OD x 0.203" THK)	48"	
P40-278X072	PIPE 2.5 SCH40 (2.875" OD x 0.203" THK)	72"	
P40-278X096	PIPE 2.5 SCH40 (2.875" OD x 0.203" THK)	96"	
P40-278X120	PIPE 2.5 SCH40 (2.875" OD x 0.203" THK)	120"	
P40-278X126	PIPE 2.5 SCH40 (2.875" OD x 0.203" THK)	126"	
P40-278X150	PIPE 2.5 SCH40 (2.875" OD x 0.203" THK)	150"	
P40-278X174	PIPE 2.5 SCH40 (2.875" OD x 0.203" THK)	174"	
P40-312X048	PIPE 3 SCH40 (3.5" OD x 0.216" THK)	48"	
P40-312X072	PIPE 3 SCH40 (3.5" OD x 0.216" THK)	72"	
P40-312X126	PIPE 3 SCH40 (3.5" OD x 0.216" THK)	126"	
P40-312X150	PIPE 3 SCH40 (3.5" OD x 0.216" THK)	150"	
P40-312X174	PIPE 3 SCH40 (3.5" OD x 0.216" THK)	174"	

NOTE:
APPROVED SMART KIT VENDORS ARE ALLOWED TO SUBSTITUTE AT THEIR DISCRETION PIPES LISTED ON THIS PAGE FOR CUSTOM LENGTH COMPONENTS OF MATCHING SIZE. SUBSTITUTIONS SHALL MEET THE ORIGINAL STRUCTURAL INTENT.

- 1. ALL PIPE GRADE A53-B OR BETTER.
- 2. HOT-DIPPED GALVANIZED PER ASTM A123.
- 3. ALL HOLES ARE 11/16" DIA. U.N.O
- 4. HOLES MAY OR MAY NOT BE PRESENT, DEPEND UPON MANUFACTURE DISCRETION.
- 5. ALL FIELD CUT AND DRILLED SURFACES SHALL BE REPAIRED WITH A MINIMUM OF TWO COATS OF ZINGA OR ZINC COTE PER ASTM A780 AND MANUFACTURER'S RECOMMENDATIONS.

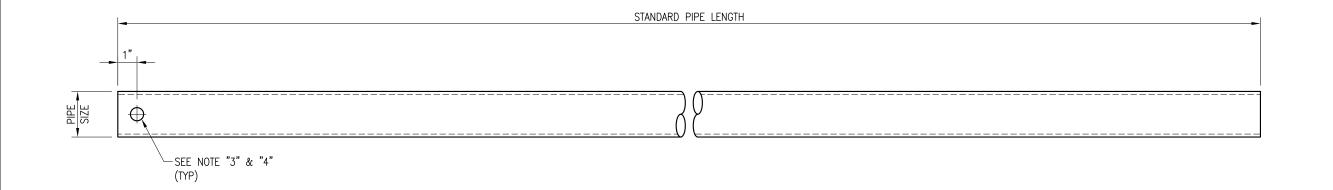VzW SMART Tool® Vendor


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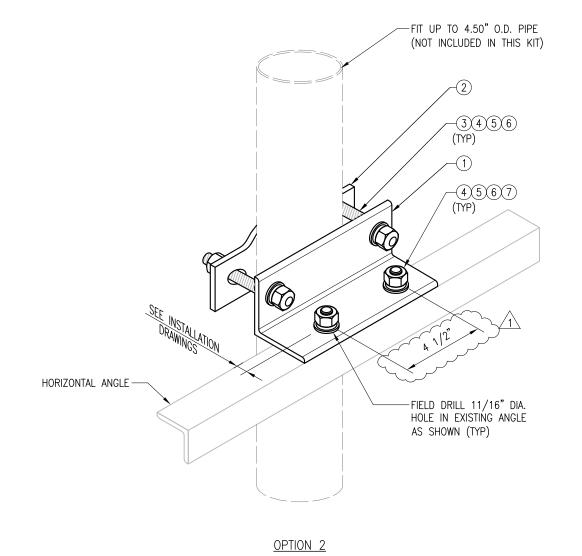
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VZWSMART STANDARD PIPE

REV #:

SHEET NUMBER: VZWSMART-PIPE



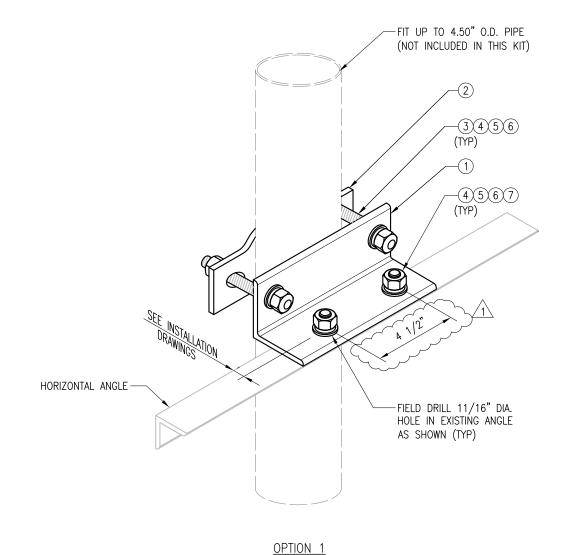

ANGLE TO ANGLE CROSSOVER KIT

VZWSMART-MSK7 (ANGLE TO ANGLE CROSSOVER KIT)					
ITEM NO.	QTY.	PART NO.	DESCRIPTION	SHEET #	WT
1	1	L3325-0.7	L 3" X 3" X 1/4" X 0'-8" A36	MSK7-F2	3.33
2	1	VCP	PL 1/2" X 2" X 8 5/8" A36 BENT PLATE	MSK7-F1	2.4
3	2		BOLT 5/8" DIA. X 6" FULL THREAD SAE GR 5		
4	4	NUT-625	5/8" HDG HEX NUT		0
5	6	FW-625	5/8" HDG USS FLAT WASHER		0
6	4	LW-625	5/8" HDG LOCK WASHER		0
7	2		BOLT 5/8" X 2" A325		0
			GALV	/ANIZED WT	7

VzW SMART Tool[©] Vendor

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	/ZWSMART-MSK7	1

NOTES:

1. HOT-DIPPED GALVANIZED PER ASTM A123.

2. USE PROVIDED ADDITIONAL FLAT WASHERS FOR CONNECTING TO 3/16" THICK HORIZONTAL ANGLE

ATTACHMENT B-6

Equipment Compound and Antenna Facilities

Equipment Compound and Shelter: 11'-8" x 16' area identified as the Licensee's Shelter on Attachment A-2(C) and A-3.

Antenna Facilities:

Type: (6) Amphenol CWWX063X25G00 Antennas

(3) Amphenol W85-19-X28-T2-1920 Antennas

(3) Samsung L-SUB 6 MT6407-77A Antennas

(3) B2/B66A RRH BR049

(3) B5/B13 RRH BR04C

(1) 12-OVP Tower

(2) 6-OVP Tower

(2) 6-OVP Shelter

(3) Amphenol MKS09T07TWIN mounts

Centerline Height: 121-124'

Cables: (6) 1-5/8" Coax Cables

(1) 12 x 24 Hybriflex Cable(2) 6 x 12 Hybriflex Cables

(3) 1/4" Homerun RET Cables

Fiber Junction Box and 4" Fiber Conduit

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